DA Form 2 – Building work details

Approved form (version 1.2 effective 7 February 2020) made under Section 282 of the Planning Act 2016.

This form must be used to make a development application involving building work.

For a development application involving **building work only**, use this form (*DA Form 2*) only. The DA Forms Guide provides advice about how to complete this form.

For a development application involving **building work associated and any other type of assessable development** (i.e. material change of use, operational work or reconfiguring a lot), use *DA Form 1 – Development application details* **and** parts 4 to 6 of this form (*DA Form 2*).

Unless stated otherwise, all parts of this form **must** be completed in full and all required supporting information **must** accompany the development application.

One or more additional pages may be attached as a schedule to this development application if there is insufficient space on the form to include all the necessary information.

This form and any other form relevant to the development application must be used to make a development application relating to strategic port land and Brisbane core port land under the *Transport Infrastructure Act 1994*, and airport land under the *Airport Assets (Restructuring and Disposal) Act 2008*. For the purpose of assessing a development application relating to strategic port land and Brisbane core port land, any reference to a planning scheme is taken to mean a land use plan for the strategic port land, Brisbane port land use plan for Brisbane core port land, or a land use plan for airport land.

Note: All terms used in this form have the meaning given under the Planning Act 2016, the Planning Regulation 2017, or the Development Assessment Rules (DA Rules).

PART 1 - APPLICANT DETAILS

1) Applicant details	
Applicant name(s) (individual or company full name)	Longhorn Transport Pty Ltd. Kym + Graham Johnson
Contact name (only applicable for companies)	Kym + Graham Johnson
Postal address (PO Box or street address)	JPO BOX 103
Suburb	Tambo
State	DLD.
Postcode	4478
Country	Australia
Contact number	6429979557
Email address (non-mandatory)	kym and gidgeca biggond. com
Mobile number (non-mandatory)	3 3 3
Fax number (non-mandatory)	
Applicant's reference number(s) (if applicable)	

PART 2 - LOCATION DETAILS

2) Location of the premises (complete 2.1 and 2.2 if applicable)
Note: Provide details below and attach a site plan for any or all premises part of the development application. For further information, see <u>DA Forms Guido: Relevant plans.</u>
2.1) Street address and lot on plan
Street address AND lot on plan (all lots must be listed), or
Street address AND lot on plan for an adjoining or adjacent property of the premises (appropriate for development in water but adjoining or adjacent to land e.g. jetty, pontoon. All lots must be listed).



Unit No.	Street No.	Street Name and Type)	Suburb	
	LOTIT	Davidson 1	Road	Tam	lata
Postcode	Lot No.	Plan Type and Numbe	r (e.a. RP SP)		rnment Area(s)
4418	17	SP148104	2	The state of the s	
2.2) Additiona	l premises ·			Tam	W()
3) Are there a Note: Easement how they may affer application Tho	ny existing easen uses vary throughout ect the proposed deve assement location URTHER DI	nents over the premises? Queensland and are to be ider elopment, see the <u>DA Forms G</u> s, types and dimensions	on hiffied correctly and a uide are included in p	accurately. For furt plans submitted	
	4	ager(s) who will be asses reed to apply a supersed			
	y of the decision	notice is attached to this	development ar	nlication	velopment application? equest – relevant documents
7) Information r	equest under Pa	rt 3 of the DA Rules	3		
		tion request if determined	Name of the last o		
Note: By not agree that this devel application and Rules to accep parties. Part 3 of the D.	ee to accept an in ing to accept an infor lopment application w d the assessment ma at any additional inform A Rules will still apply	Tormation request for this mation request I, the applicant, ill be assessed and decided by	s development a acknowledge: used on the informati is relevant to the dev int for the development tion listed under section	pplication on provided when elopment applicati nt application unle	making this development on are not obligated under the DA ss agreed to by the relevant
B) Are there any	associated deve	elopment applications or	current approval	s?	
☐ Yes – provid ☑ No	e details below o	r include details in a sch	edule to this dev	elopment appli	cation
ist of approval/	development	Reference	Date		Assessment manager
☐ Approval ☐ Developmen	t application				
Approval Development	t application				

9) Has the portable long serviYes – a copy of the receipt	ce leave levy been haid?		
	rovide evidence that the po ides the development appli val only if I provide evidence	ortable long service leave levy cation. I acknowledge that the ce that the portable long serv	/ has been paid before the e assessment manager may ice leave levy has been paid
Amount paid	Date paid (dd/mm/yy)		mber (A, B or E)
\$	P (
10) Is this development applic	cation in response to a sho	w cause notice or required as	s a result of an enforcement
notice? Yes – show cause or enfor No	rcement notice is attached		
11) Identify any of the followir application	ng further legislative require	ements that apply to any asp	ect of this development
☐ The proposed developmer	age Register. See the guid	dance provided at www.des.d	egister or in a local lld.gov.au about the
Name of the heritage place:		Place ID:	
		The A the contract of	
☐ Yes – the <i>Referral checklis</i> No – proceed to Part 5	st for building work is attac	hed to this development app	lication
13) Has any referral agency p	provided a referral respons	e for this development applic	
			ation?
	received and listed below	are attached to this develop	
☑ No	received and listed below		
☑ No Referral requirement		Referral agency	Date referral response
No Referral requirement Identify and describe any cha	anges made to the propose	Referral agency development application the	Date referral response
Referral requirement Identify and describe any chareferral response and this development	anges made to the propose	Referral agency development application the	Date referral response
No Referral requirement Identify and describe any cha referral response and this device (if applicable)	anges made to the propose velopment application, or in	Referral agency development application the	Date referral response
No Referral requirement Identify and describe any cha referral response and this device (if applicable)	anges made to the propose velopment application, or in	Referral agency development application the	Date referral response
No Referral requirement Identify and describe any cha referral response and this device (if applicable)	anges made to the propose velopment application, or in	Referral agency development application the	Date referral response
Referral requirement Identify and describe any cha referral response and this der (if applicable) ART 5 – BUILDING \	anges made to the propose velopment application, or in WORK DETAILS	Referral agency d development application the include details in a schedule t	Date referral response at was the subject of the othis development application
Referral requirement Identify and describe any chareferral response and this device (if applicable) ART 5 - BUILDING V 14) Owner's details Tick if the applicant is also	anges made to the propose velopment application, or in WORK DETAILS	Referral agency d development application the include details in a schedule t	Date referral response at was the subject of the othis development application
Referral requirement Identify and describe any chareferral response and this device (if applicable) ART 5 - BUILDING V 14) Owner's details Tick if the applicant is also	work DETAILS of the owner and proceed to the mane)	Referral agency d development application the include details in a schedule t	Date referral response at was the subject of the othis development application
Referral requirement Identify and describe any chareferral response and this device (if applicable) ART 5 — BUILDING \ 14) Owner's details Tick if the applicant is also Name(s) (individual or company furch contact name (applicable for contact na	work DETAILS of the owner and proceed to the	Referral agency d development application the include details in a schedule t	Date referral response at was the subject of the othis development application
Referral requirement Identify and describe any chareferral response and this device (if applicable) ART 5 — BUILDING V 14) Owner's details Tick if the applicant is also Name(s) (individual or company fu	work DETAILS of the owner and proceed to the	Referral agency d development application the include details in a schedule t	Date referral response Date referral response at was the subject of the othis development application

Postcode				
Country				
Contact number		 		
Email address (non-mandatory)				
Mobile number (non-mandatory)		 		
Fax number (non-mandatory)	<u> </u>			
The state of the s		<u> </u>		
15) Builder's details				
☐ Tick if a builder has not yet following information.	beeп engaged	l to undertake	the work and proceed to	16). Otherwise provide the
Name(s) (individual or company full	name)	Andri	W KUSSU	
Contact name (applicable for comp		,, ,, ,,	W KUIDOVI	
QBCC licence or owner – build		124	6385	
Postal address (P.O. Box or street		<u> </u>	6300	
Suburb	udaroco,	Blav	6 11	
State		DIAV	avi	
Postcode		YIU	-7 -	
Contact number		- 4 4	16 2072 T 1	<)
Email address (non-mandatory)		<u>UT </u>	39725 6	34
Mobile number (non-mandatory)		_apro	15)-01/10 @ gr	nail.com
Fax number (non-mandatory)				
T ax Humber (non-manuatory)				
16) Provide details about the pr	ronosed buildir	na work		
What type of approval is being				
Development permit			<u> </u>	
☐ Preliminary approval				
b) What is the level of assessm	ent?			
Code assessment				
Impact assessment (requires p	public notification)			
c) Nature of the proposed buildi			OYAS)	
New building or structure	<u>.</u> ,			alterations or additions
Change of building classifica	ation <i>(involving b</i> u	vildina work)		pool and/or pool fence
☐ Demolition		maning viewy	☐ Relocation	
d) Provide a description of the w	vork below or in	n an attached	echadula	1 or removal
Truck Shed		TI MII MIMOTIUS	30 leudie.	
e) Proposed construction materi	ials			
-1	Double br		Z Crast	
External walls	☐ Brick veneer		☑ Steel ☑ Timber	☐ Curtain glass
	Stone/con		Fjbre cement	☐ Aluminium ☐ Other
Γ	☐ Timber		Steel	
Frame	Other		E 01001	☐ Aluminium
Floor	Concrete		Timber	Other
Des Carrieda d	☐ Slate/cond	crete	☐ Tillés	
Roof covering	Aluminium		Steel	☐ Fibre cement ☐ Other
f) Existing byilding use/classifica				
Industrial:				

g) New building use/classifica	tion? (if applicable)		
h) Relevant plans Note: Belevant plans are required to Relevant plans.	be submitted for all aspects of this	development app	plication. For further information, see <u>DA Forms Guide:</u>
Relevant plans of the prop	osed works are attached to t	the developm	ent application
		I-O	
17) What is the monetary values 38360	ue of the proposed building w	vork?	
18) Has Queensland Home V	Varranty Scheme Insurance I	been paid?	
Yes – provide details belo			21.01
No Octub WU	Date paid (dd/mm/yy)	When	paron
Amount paid	Date paid (dd/mm/yy)		Reference number
\$			
ART 6 - CHECKLIST	T AND APPLICANT	DECLAR	ATION
19) Development application	checklist		
The relevant parts of Form 2	- Building work details have	been comple	eted Yes
This development application operational work and is acco	includes a material change	of use, recon	figuring a lot or
application details	ment are attached to this de	avolonment a	polication
Relevant plans of the development Relevant plans are required to information, see <u>DA Forms Guide:</u>	be submitted for all aspects of this	development ap	pplication. For further Yes
The portable long service lea a development permit is issu	ive levy for QLeave has beer ed (see 9)	n paid, or will	be paid before
20) Applicant declaration			
By making this developm			on in this development application is true and
from the assessment mainformation is required or	nager and any referral agend permitted pursuant to sectio	cy for the deve ons 11 and 12	It to receive future electronic communications elopment application where written to the Electronic Transactions Act 2001
Note: It is unlawful to intentionally p	provide false or misleading information	on.	
assessment manager, any rebe engaged by those entities	eferral agency and/or buildings) while processing, assessin	g certifier (inc ng and decidir	ne assessment manager and/or chosen sluding any professional advisers which may ng the development application.
All information relating to this	s development application m	ay be availab	le for inspection and purchase, and/or
published on the assessmen	nt manager's and/or referral a	unrelated to the	he <i>Planning Act 2016</i> , Planning Regulation
2017 and the DA Rules exce	ept where:		
such disclosure is in acc Act 2016 and the Plannir	ordance with the provisions and Regulation 2017, and the	about public a access rules	access to documents contained in the <i>Plannin</i> made under the <i>Planning Act</i> 2016 and
Planning Regulation 201required by other legislat	7; or tion (including the <i>Right to In</i>	formation Act	t 2009); or
 otherwise required by lay 	N.		
This information may be sto Public Records Act 2002.	red in relevant databases. Th	ne information	n collected will be retained as required by the

PART 7 - FOR COMPLETION BY THE ASSESSMENT MANAGER - FOR OFFICE **USE ONLY** Date received: Reference numbers: For completion by the building certifier Classification(s) of approved building work Name QBCC Certification Licence QBCC Insurance receipt number number Notification of engagement of alternative assessment manager Prescribed assessment manager Name of chosen assessment manager Date chosen assessment manager engaged Contact number of chosen assessment manager Relevant licence number(s) of chosen assessment manager Additional information required by the local government Confirm proposed construction materials: ☐ Double brick Steel ☐ Curtain glass External walls ☐ Brick veneer Timber ☐ Aluminium ☐ Stone/concrete Fibre cement ☐ Other ☐ Timber Steel Frame ☐ Aluminium Other Floor ☐ Concrete ☐ Timber ☐ Other ☐ Slate/concrete ☐ Tiles ☐ Fibre cement Roof covering ☐ Aluminium ☐ Steel ☐ Other QLeave notification and payment Note: For completion by assessment manager if applicable Description of the work QLeave project number Amount paid (\$) Date paid (dd/mm/yy) Date receipted form sighted by assessment manager Name of officer who sighted the form Additional building details required for the Australian Bureau of Statistics Existing building use/classification? (if applicable) New building use/classification? Site area (m²)

Floor area (m²)

Form 15 Compliance certificate for building design or specification



This form is to be used by an appointed competent person for the purposes of section 10 of the *Building Act 1975* and sections 73 and 77 of the Building Regulation 2021 (Design-specification certificate) stating that an aspect of building work or specification will, if installed or carried out as stated in this form, comply with the building assessment provisions.

Additional explanatory information is included in the Appendix at the end of this form,

1. Property descrip	ption
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This section need only be completed if details of street address and property description are applicable.

E.g. in the case of (standard/generic) pool design/shell manufacture and/ or patio and carport systems this section may not be applicable.

The description must identify all land the subject of the application.

The lot and plan details (e.g. SP/RP) are shown on title documents or a rates notice.

If the plan is not registered by title, provide previous lot and plan details.

Street address (include number, street, suburb/locality and postcode)

UT 17 DAVIDSOU T

PMBO StateU

Lot and plan details (attach list if necessary)

Local government area the land is situated in

2.Description of aspect/s certified

Clearly describe the extent of work covered by this certificate, e.g. all structural aspects of the steel roof beams.

12m spany 27m was 4 5.1m exter open Ender Greek GHED Feaming

CONNECTIOUS

FOUNDATION PIERS ONLY

SITE BEGION A TERRANICAT 2.0

3. Basis of certification

Detail the basis for giving the certificate and the extent to which tests, specifications, rules, standards, codes of practice and other publications were relied upon.

AS 1170.0-2002

No 4100 - 2020

K53623-1993

AS 170.1 - 2002

KS 4600.2018

AS1289-2014

AS 1710. 2 - 2021

NS 1562-1-2018

AS3700 - 2018

AS170. 3 - 2003

AS 4678 - 2002

MS 4773 - 2015

AS 1170.4-2007

as 1680 - 2080

MS 3900.1,2,3-2021

AS 2870 - 2018 AS 2870 - 2011 AS 1720 .1-2010

NS 4045 - 2012

Scalnec 2022

4. Reference documentation ATTACHED PLANS & DETAILS Clearly identify any relevant 34744-15 SUBERS DATED 10-6.23 documentation, e.g. numbered structural engineering plans. 5. Building certifier reference Building certifier reference number number and building development application number Building development application number (if available) 6.Appointed competent person Name (in full) details GEORGE ZUEV Under Part 6 of the Building Company name (if applicable) Contact person Regulation a person must be assessed as a competent for the type TECHNIBULD CONSULTING acorge zuev of work (design-specification) by the Business phone number Mobile number relevant building certifier. 0264 036061 0410 038 301 Email address HIGHEPE @ BIGRAND. NET. AU Postal address PO BOX 5020 COBARGO NSW State NSW Postcode 2550 Licence class or registration type (if applicable) PEGISTERED PROFESSIONAL ENGINEER Licence or registration number (if applicable) EPEQ 7551 7. Signature of appointed competent Signature Date 23 JUN 2023 This certificate must be signed by the individual assessed and appointed by the building certifier as competent to give design-specification help. **LOCAL GOVERNMENT USE ONLY**

Appendix - explanatory information

IMPORTANT NOTE: It is an offence for a competent person to give a building certifier a document, including this form, that the person knows or reasonably suspects, is false or misleading.

Who can complete this certificate? (sections 10 of the *Building Act 1975* (Building Act) and 73 of Building Regulation 2021 (BR 2021)) A building certifier can accept from a competent person (design – specifications) a certificate stating that the competent person has assessed the building design or specification for the aspect of building work, and it will, if installed or carried out under the certificate, comply with the building assessment provisions, including any relevant standards and codes.

Schedule 10 of the BR 2021 defines building design or specification as any material, system, method of building or other thing related to the design of or specifications for building work.

For a competent person to meet the regulation requirements (section 77 of the BR 2021) they must substantially complete all sections of this form, including information, such as the design of a particular material, system, method of building or that a building element complies with the Building Code of Australia or a provision of the Queensland Development Code. It is also important that the details of the relevant reference documents are included, for example, the applicable Australian Standards or other technical provisions that may be applicable to the subject work.

What is the purpose of this form? (section 10 of the Building Act 1975)

The information in this form informs the building certifier's decision making when they are assessing a building development application and issuing the building development approval for the building work the subject of the certificate (form).

When is this form not required?

The assessment of some building applications will be entirely within the expertise of the relevant building certifier and therefore they may not seek the help of a competent person. In these instances, this form is not required.

is a manufacturer or supplier required under the BR 2021 to complete and sign this Form 15, if requested?

No. A manufacturer or supplier of building materials is not required to complete and give this form or any aspect and inspection certificates if requested by a construction contractor, builder, appointed competent person, or a building certifier.

However, a manufacturer or supplier <u>may give</u> the construction contractor, builder, competent person or the building certifier evidence of suitability such as a manufacturers statement for an aspect or material that it is compliant with the relevant reference documents in the BCA i.e. the applicable Australian Standard/s.

What if there is not enough space for all the supporting material/documents?

Items 2, 3 and 4 requires the competent person to clearly identify the extent of the assessment that was undertaken for aspect/s of work identified in this form.

For instance, there is provision for material such as specifications, standards, codes or other relevant publications to be referenced in the form. However, if the space in the form is not sufficient to accommodate all of this material, you can create and refer to additional material in an addendum or attachment to the form.

The form is also available in a Microsoft Word version, that you can download and edit to include additional material in the relevant parts of the form. Note that editing the form in the Microsoft Word version may cause the relevant boxes to expand and increase the length of the document. This is acceptable and does not change the approved form, provided the section text (description on the left-hand side of the page) is not altered.

Appointed competent person (design or specification) – (sections 34 and 36 of the BR 2021)

A building certifier must assess and decide to appoint an individual as a competent person before they can, as a competent person, give design-specification help. The building certifier is required to keep detailed records about what was considered when appointing a competent person.

A building certifier must be satisfied that an individual is competent to give the type of inspection help having regard to the individual's experience, qualifications and skills and if required by law to hold a licence or registration, that the individual is appropriately registered or licensed.

An individual is appointed as competent to give design-specification help on or from a particular day. The building certifier can also decide an individual is a competent person (design-specification) and a competent person (inspection) at the same time or for the same systems or components of the work.


For further information about assessment of someone as a competent person refer to the Guideline for the assessment of competent persons.

PRIVACY NOTICE

The Department of Energy and Public Works is collecting personal information as required under the *Building Act 1975*. This information may be stored by the Department, and will be used for administration, compliance, statistical research and evaluation of building laws. Your personal information will be disclosed to other government agencies, local government authorities and third parties for purposes relating to administering and monitoring compliance with the *Building Act 1975*. Personal information will otherwise only be disclosed to third parties with your consent or unless authorised or required by law.

GENERAL NOTES

- G1. Do not scale drawings. Written dimensions shall have precedence over scaled drawings Dimensions, conditions and levels to be verified on site, report any discrepancies to the applicable
- Australia, relevant Australian Standards, relevant codes and manuals, local municipal by-laws and G2. All new construction work and the installation of services must comply with the Building Code of requirements of the relevant authorities.
- G3. This building design should be reviewed by an appropriately qualified person with regards to the relevant Occupations Health & Safety Act in your state
- with Zincalume or Colorbond Steel (roof & wall sheeting). Such contact will ultimately result in G4. Moisture or Moisture Retaining materials should not be permitted to remain in intimate contact perforation (rust) of the material.
- damage to the building. In order to minimise the damage we recommend the following precautions are G5. Clay soils will swall and shrink with variations in moisture content. This movement may cause
- Provide adequate site drainage to ensure water will not pond against or near the building.
- Grade the site within 2.0m of the building away from building, to ensure that water will not pond
- they do occur they should be repaired promptly. Maintain sewerage, stormwater and other drainage systems so that leakages will not occur. If
- height to the building. Avoid establishing garden beds next to the building. Gardens and lawns Trees and shrubs should not be planted or allowed to exist, closer than 0.75 times their mature to prevent damage to the foundations during dry spells or drought. should be watered adequately but not excessively. Uniform, consistent watering can be important

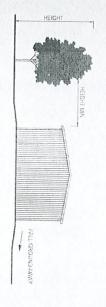



CONCRETE

- C1. All workmanship and materials shall be in accordance with AS 3600 current editions with amendments, except where varied by the contract documents
- C2. Concrete Characteristics

20 mm	80mm ± 15	25 MPa	ootings
80mm ± 15 20 mm		25 MPa	Piers

spaced at 1000ctrs maximum. Cover shall not be less than the size of the aggregate or the main bars, C3. Cover to reinforcement shall be obtained by the use of approved bar chairs. All bar chairs to be

Concrete Cover

= 65mm U.N.O

Footings Strip Footings = 50mm U.N.O = 50mm U.N.O.

C4. Sizes of concrete elements do not include thickness of applied finish

C5. No holes, chases or embedment of pipes other than those shown on the structural drawings shall be made in concrete members without the approval of the Engineer.

C6. Construction, joints shall be properly formed and located only where shown or specifically approved by the Engineer.

C7. Reinforcement is represented diagrammatically, it is not necessarily shown in true projection.

C8. Splices in reinforcement shall be made only in the positions shown, unless the approval of the engineer is obtained for any other splice.

C9. Welding of reinforcement will not be permitted unless noted on the structural drawings

C10. Pipes or conduits shall not be placed within the cover to reinforcement without the approval of

C11. Reinforcement is to be supplied and bent in accordance with AS 1302, AS 1303 & AS 1304 current editions and amendments. Reinforcement is doneted by the following symbols

denotes structural grade round bars grade 250

denotes hot rolled deformed

denotes hard drawn steel wire square fabric

denotes hard drawn steel wire rectangular fabric

denotes hard drawn steel wire trench mesh

C12. All reinforcement for any one pour shall be completely placed and tied prior to inspection. No

C13. Foundations to be cast onlin a naturally compacted subgrade or approved compacted fill

concrete shall be poured until reinforcement has been inspected and approved.

compaction to be to a minimum of 98% standard dry density to AS 1289.E1.1

C14. All concrete shall be properly compacted by means of approved vibrators

C15. Where walls are non-load bearing at either horizontal or vertical faces they shall be separated from concrete or brickwork by 10mm thick bituminous canite or similar.

directed by the Engineer. Vertical faces of concrete to be kept free by a 10mm thickness bituminous C16. Concrete shall be separated from supporting masonry by two layers of suitable membrane or as canite or similar



STRUCTURAL STEELW

- \$1. All workmanship and materials shall be in accordance with AS 41
- Unless noted otherwise all steel shall be in accordance with
- AS 3678 and AS 3679 Grade 300 for rolled sections
- AS 1163 Grade 350 for square hollow sections
- AS 1074 Grade 200 for circular hollow sections
- AS 1397 Grade 450 for cold formed light gauge sections
- S3. The contractor shall provide temporary bracing as necessary erection and leave in place until permanent bracing elements are con-
- S4. Welding if required shall be in accordance with AS 1554 and
- \$5. Welds shall be 6mm continuous filet unless noted otherwise
- Butt welds are to be complete penetration butt welds as define
- bolts shall be installed in accordance with manufacturers directions. Use washers S7. Refer to structural drawings for purlin and girt sizes and spa
- M12 4,8/S for sections up to 250mm deep
- M16 4.6/S for sections over 250mm deep
- Purlin cleats shall be 5mm thick, with 6mm chw, unless otherwise r
- S9. Bolt type and procedure is as follows:
- using a standard wrench to a 'snug tight' condition 4.6/S Refers to commercials bolts of strength grade 4,6 confor
- using a standard wrench to a 'snug tight' condition. 8.8/S Refers to high strength bolts of strength grade 8.8 confor
- 8.8/TF Refers to high strength bolts of strength grade 8.8 co
- \$10. All Structural steelwork below ground to be encased by concrete tensioned in a controlled manner to the requirements of AS 4100.
- steelwork to be given one shop coat of approved paint unless otherwise \$11. Concrete encased structural steel to be enclosed by SL41 steelwork. Encasing to provide 50mm min. cover, 75mm min. cove

BRICKWORK / BLOCKWO

- B1. All brickwork / blockwork shall comply with AS 3700
- B2. Mortar to brickwork / blockwork shall be 1:1:6 unless otherwise spe-
- B4. Minimum compressive strength of concrete blocks to be 15Mpa unit B3. Minimum compressive strength of brick to be 30Mpa unless otherwi
- B5. All joints in brick and I or block walls to be in accordance with the
- B6. Cavity wall ties to be in accordance with current standards and requ

B7. All steel columns, multions and horizontal supports, provide 3.2n

steelwork in an approved manner at 500ctrs.

B8. Provide articulation / expansion joints at 6.0m ctrs. max



1300 MAX GIRT SPACING

COLUMN

EAVE PURLIN BRACKET
3,0MM GALV C150 EAVE BRACKET
4/ M12 X 30mm G 8,8 FLANGE PURLIN BOLT
2/ 14-10 X 26 CLASS 4 HEX HEAD TEKS

0 0

10000

MANA COMERAPEX PLATE

17.5.MM GALV CZ90 APEN MAIN PLATE

17.2.MM GALV CZ90 APEN INTERNAL PLATE

18.1112.X 20MM GALV EL90 APEN INTERNAL PLATE

18.1112.X 20MM GALV EL90 APEN INTERNAL PLATE

19.1112.X 20MM GALV EL90 APEN INTERNAL

20.1112.X 20MM GAL

000 The second second 10 deg

TH96X0.75 STRUCTURAL BATTEN

GIRT TO RAFTER
3/14-10 X 20 CLASS 4 HEX TEKS

1200 MAX GIRT SPACING

ROOF SHEETING CUSTOM ORB 0,47 TCT ZINCALUME 12-14 X 35 CLASS 4 HEX SEAL TEKS ZINCALUME

0

0

0

Q

0 10

0

0

0

0

0 0

WALL SHEETING
CUSTOM ORB 0,47 TCT ZINCALUME
10-16 X 16 CLASS 4 HEX SEAL TEKS ZINCALUME

000

000

MAIN & COMER KINEE PLATE
17.3.GAM GALV MAIN KINEE PLATE C250
17.2.4MM GALV INTERNAL KINEE PLATE C250
207.MT2 X.30MM G 8.8 FLANGE PRIGN BOLT
207.MT2 X.30MM G 8.8 FLANGE PRIGN BOLT
307.MT2 X.30MM G 8.8 FLANGE PLATE
87.14-10 X.20 CLASS 4 HEX TEKS

TH96X0,75 STRUCTURAL BATTEN

ESTABLISHED BUILDING DESIGNS

DESCRIPTION

DETAILED CONNECTIONS DETAIL

ESTABLISHED BUILDING DESIGNS PTY LTD

LONGHORN TRANSPORT PTY LTD LOT 17 DAVIDSON RD

PROPOSED PROJECT

ABN 93 074-651 899

STRUCTURAL AND CIVIL ENGINEERS TECHNIBUILD CONSULTING

SCALE N.T.S REGION: A SIZE: A3 REGIONAL WIND SPEED V(500): DESIGN: E.B.D. 45 MVS TERRAIN CAT: 2 DATE: 19/06/2023 DRAWN BY: NJW

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JOHNS034744 - 02

300 210

3/14-10 X 20 CLASS 4 HEX TEKS FOCHING CONNECTION

20MM UNIVERSALL FOOTING BRACKET G35) HOT DIPPED GALV

20MM SAMM G & ASSEMBLED PURRINBOLT (TO FOOTING BRACKET/GOLUMN CONNE

20MB X 30MM G & B HDG BOLTS (IN CONCRETE BRACKET CONNECTION)


George Zuev RPEQ 7551

2 3 JUN 2023

PO Box 303, Fitzroy, VIC, 3065

60 Princes Highway, Cobargo NSW 2550 Telephone & Fax (02) 6 936 061 Mobile (0419) 938 301

www.establishedbuildingdesigns.com.au

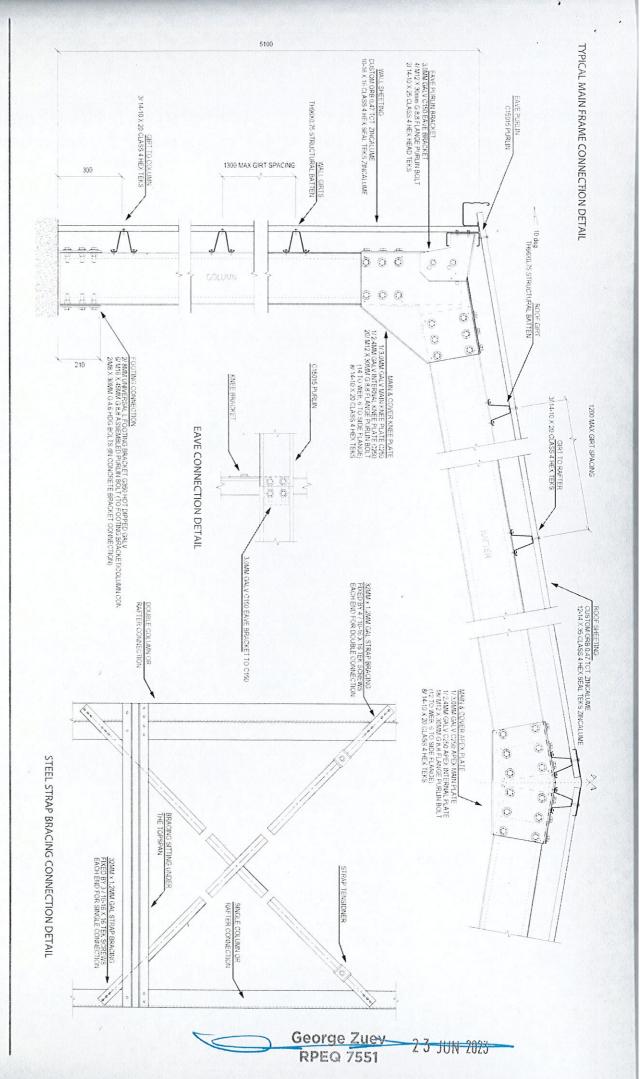

ESTABLISHED BUILDING DESIGNS

ESTABLISHED BUILDING DESIGNS PTY LTD

PO Box 303, Fitzroy, VIC, 3065

www.establishedbuildingdesigns.com.au

PROPOSED PROJECT

DUBLIOUS TRANSPORT PTY LTD

TAMBO QLD 4478

DETAILED CONNECTIONS DETAIL

DESCRIPTION

60 Princes Highway, Cobargo NSW 2550 Telephone & Fax (02) 6 936 061 Mobile (0419) 938 301 ABN 93-074-651-899 STRUCTURAL AND CIVIL ENGINEERS

SCALE: N.T.S REGION: A REGIONAL WIND SPEED V(500): 45 M/S SIZE: A3 DESIGN: E.B.D JOHNS034744 - 03 TERRAIN CAT: 2 DATE: 19/06/2023

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ESTABLISHED BUILDING

DESIGNS

DESCRIPTION

DETAILED CONNECTIONS DETAIL

60 Princes Highway, Cobargo NSW 2550 Telephone & Fax (02) 6 936 061 Mobile (0419) 938 301

REGION: A

SCALE: N.T.S DESIGN: E.B.D SIZE: A3 REGIONAL WIND SPEED V(500): 45 M/S DATE: 19/06/2023 TERRAIN CAT: 2

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JOHNS034744 - 04

- S, M OR H1 SITES ONLY

PROPOSED PROJECT Johnson, Kym

LONGHORN TRANSPORT PTY LTD LOT 17 DAVIDSON RD
TAMBO QLD 4478

ESTABLISHED BUILDING DESIGNS PTY LTD

High Springs Development Pty Ltd ABN 93 074 651 899

PO Box 303, Fitzroy, VIC, 3065 F: 1300 660 554

www.establishedbuildingdesigns.com.au

PIERS WITH SLAB \$

TECHNIBUILD CONSULTING STRUCTURAL AND CIVIL ENGINEERS

FOOTING CONNECTION

FOR TOPING CONNECTION

FOR THE PROPERTY OF DEFORMED BARS 7/ N12 DEFORMED BARS 210 210 PIERS ONLY \$

INDICATION OF DATIONS OF When STORIGO BROWN RESERVING PROPERTY AND STORIGOUS OF THE STORY OF THE


DEFORMED BARS


50




FOOTING BRACKET FOR SINGLE COLUMN - PIER ONLY

FOOTING BRACKET
FOR SINGLE COLUMN -WITH SLAB

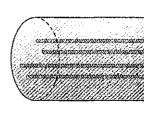


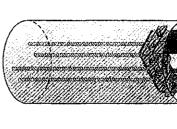

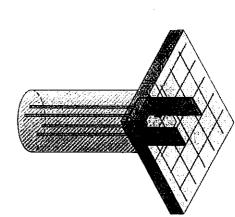

FOR BTB COLUMN -WITH SLAB SLAB BUTTING PIER

George Zuev

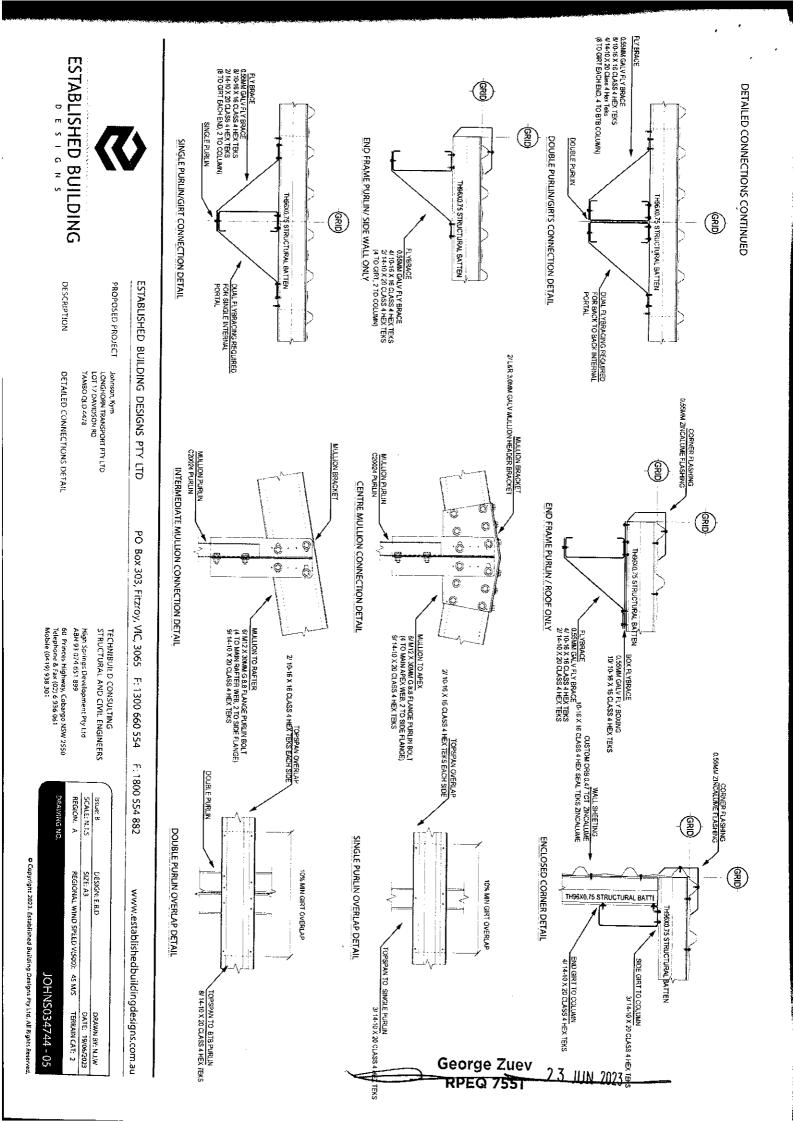



NS DRAWN BY

JOB DETAILS

CUSTOMER: Longhorn Transport Pty Ltd, Kym Johnson

SITE: Lot 17 Davidson Rd, Tambo, QLD, 4478

PROPOSED PROJECT: Johns034744 | 13m x 27m x 5.1m · Permeable Building


DRAWING DETAILS

DRAWING NO.: AP34744

DRAWING SCALE: 1:67

DRAWING TYPE: Architectural Drawings


REAR ELEVATION - 13000 FRONT ELEVATION

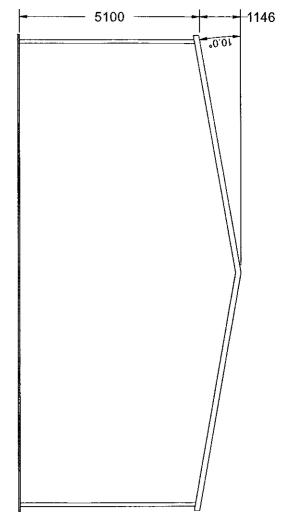

CUSTOMER: Longhorn Transport Pty Ltd, Kym Johnson SITE: Lot 17 Davidson Rd, Tambo, QLD, 4478 PROPOSED PROJECT: Johns034744 | 13m x 27m x 5 1m - Permeable Building

JOB DETAILS

PLANS DRAWN BY

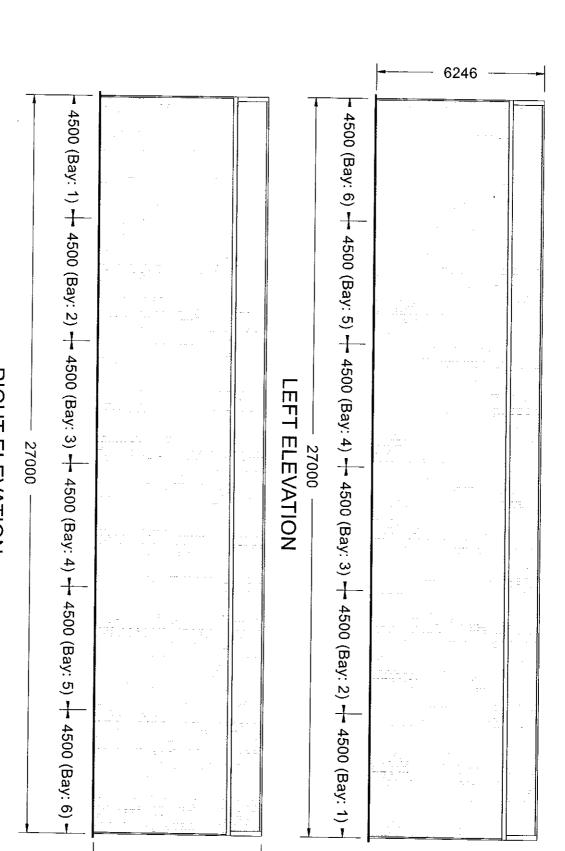

6246

RIGHT ELEVATION

DRAWING DETAILS

DRAWING NO.: AP34744

DRAWING TYPE: Architectural Drawings

DRAWING SCALE: 1:88

George Zuev 2.3 JUN 2023 RPEQ 7551



SITE: Lot 17 Davidson Rd, Tambo, QLD, 4478

CUSTOMER: Longhorn Transport Pty Ltd, Kym Johnson

PROPOSED PROJECT: Johns034744 | 13m x 27m x 5.1m - Permeable Building

Plan Elevation

4333 4333 4333 4500 (Bay: 1) + 4500 (Bay: 2) + 4500 (Bay: 3) + 4500 (Bay: 4) + 4500 (Bay: 5) + 4500 (Bay: 6) + Bay: 1 (Right) Bay: 1 [Left] Bay: 2 [Right] Bay: 2 [Left] 8ay : 3 [Right] 8ay : 3 [Left] 27000 Bay: 4 [Right] 83y : 4 [Left] Bay : 5 [Right] Bay : 5 [Left] Bay: 6 [Right] Bay : 6 [Left] 4333 -- 4333 -4333

– 13000 -

DRAWING DETAILS

DRAWING NO.: AP34744

DRAWING SCALE: 1:95

DRAWING TYPE: Architectural Drawings

George Zuev 23 JUN 2023 RPEQ 7551

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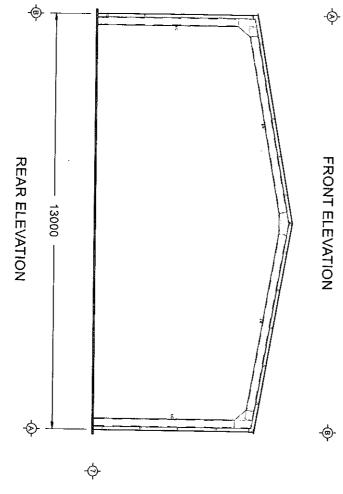
SITE: Lot 17 Davidson Rd, Tambo, QLD, 4478


CUSTOMER: Longhorn Transport Ply Ltd, Kym Johnson

PROPOSED PROJECT: Johns034744 | 13m x 27m x 5 1m - Permeable Building

DRAWING TYPE: Engineering Drawing DRAWING DETAILS DRAWING NO.: AP34744

DRAWING SCALE: 1:75



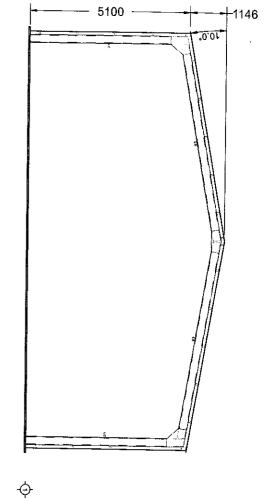

George Zuev RPEQ 7551

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PLANS DRAWN BY

JOB DETAILS

PROPOSED PROJECT: Johns034744 | 13m x 27m x 5.1m · Permeable Building

CUSTOMER: Longhorn Transport Pty Ltd, Kym Johnson

SITE: Lot 17 Davidson Rd, Tambo, QLD, 4478

DRAWING DETAILS

DRAWING NO.: AP34744

DRAWING SCALE: 1:94

DRAWING TYPE: Engineering Drawing

RIGHT ELEVATION

George Zuev RPEQ 7551 2.3 HIN 2023 PLANS DRAWN BY

JOB DETAILS

PROPOSED PROJECT: Johns034744 | 13m x 27m x 5.1m - Permeable Building


CUSTOMER: Langhorn Transport Pty Ltd, Kym Johnson

SITE: Lot 17 Davidson Rd, Tambo, QLD, 4478

DRAWING DETAILS

DRAWING TYPE: Engineering Drawing DRAWING NO.: AP34744

DRAWING SCALE: 1:47

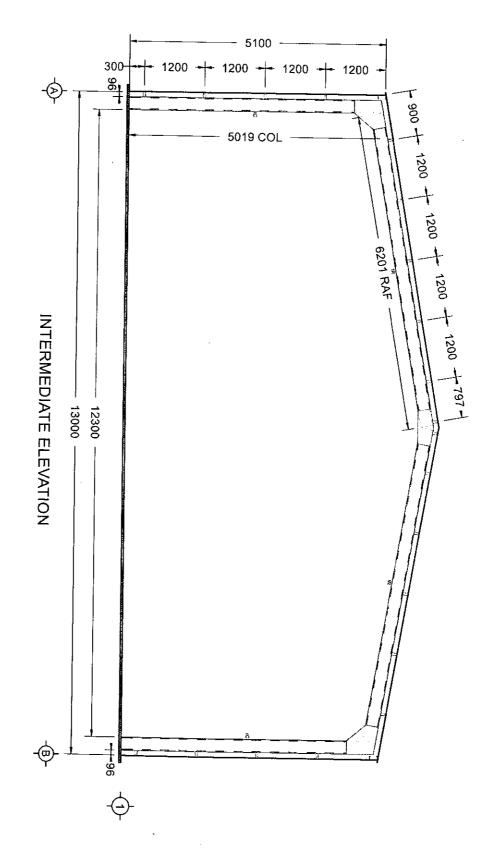



YS DRAWN BY


SITE: Lot 17 Davidson Rd, Tambo, QLD, 4478

CUSTOMER: Longhorn Transport Pty Ltd, Kym Johnson

PROPOSED PROJECT: Johns034744 | 13m x 27m x 5 1m - Permeable Building

DRAWING TYPE: Engineering Drawing DRAWING DETAILS DRAWING NO.: AP34744

DRAWING SCALE: 1:93

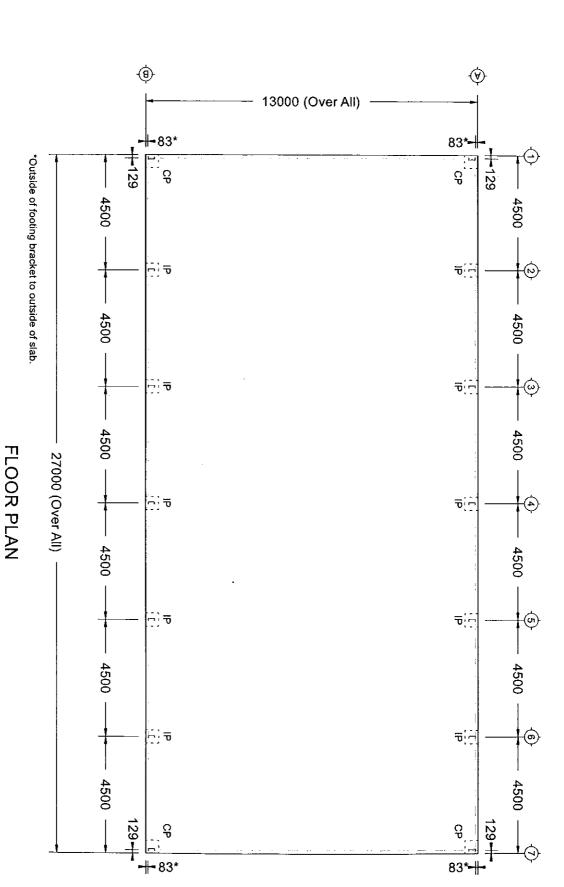



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PLANS DRAWN BY

CUSTOMER: Longhorn Transport Pty Ltd, Kym Johnson SITE: Lot 17 Davidson Rd, Tambo, QLD, 4478

PROPOSED PROJECT: Johns034744 | 13m x 27m x 5.1m + Permeable Building

JOB DETAILS

(8) ₩ 13000 (Over All) 91-129 **+129 - 4500** 4500 FB 4500 4500 æ 8 -ώ FB 4500 4500 27000 (Over All) 4 **- 4500** 4500 (6) 4500 4500 **-**4500

ROOF PLAN

DRAWING DETAILS

129+

-||-91

DRAWING NO.: AP34744

DRAWING SCALE: 1:93 DRAWING TYPE: Engineering Drawing

4500

91-



MEMBER SCHEDULE

Australia's Leading Wholesale Shed Company

CLIENT DETAILS

Customer Name Kym Johnson (Longhorn Transport Pty Ltd)

Job Number

Johns034744

Site Address

Lot 17 Davidson Rd, Tambo, QLD, 4478

BUILDING DE	TAILS						
Width	13000 mm	Length	27000 mm	Eave Height	5100 mm	Roof Pitch	10 Degree
Terrain Cat	2	Wind Region	Α	Wind Velocity	45 m/s m/s		
Side Bay Qty	6	Side Bay Width	4500 mm (Max)	End Bay Qty	3	End Bay Width	4333 mm (Max)

INTERNAL PORTAL FRA	ME
Internal Column (IC)	C25019
Internal Rafter (IR)	C25019
Knee Brace (KB)	NA
Knee Brace % Eave Height	NA
Apex Brace (AB)	NA
Apex Brace % Width	NA
Open Bay Column	NA

END PORTAL FRAME	
End Column (EC)	C25019
End Rafter (ER)	C25019
Knee Brace (KB)	NA
Knee Brace % Eave Height	NA
Apex Brace (AB)	NA
Apex Brace % Width	NA
End Wall Mullion (EWM)	NA

\$				
C15015			,	
TH96070	Max Spacing	1300 mm	% Girt Overlap	11.00%
TH96070	Max Spacing	1300 mm	% Girt Overlap	11.00%
TH96070	Max Spacing	1300 mm	% Girt Overlap	11.00%
TH96070	Max Spacing	1200 mm	% Purlin Overlap	11.00%
The state of the s	C15015 TH96070 TH96070 TH96070	C15015 TH96070 Max Spacing TH96070 Max Spacing TH96070 Max Spacing	C15015 TH96070 Max Spacing 1300 mm TH96070 Max Spacing 1300 mm TH96070 Max Spacing 1300 mm	C15015 TH96070 Max Spacing 1300 mm % Girt Overlap TH96070 Max Spacing 1300 mm % Girt Overlap TH96070 Max Spacing 1300 mm % Girt Overlap

BRACING			
Side Wall Cross Bracing	32mm x 1.2mm Steel Straping	No. of Bays Cross Braced	3 bays
Front End Wall Cross Bracing	32mm x 1.2mm Steel Straping	No. of Bays Cross Braced	0 bays
Back End Wall Cross Bracing	32mm x 1.2mm Steel Straping	No. of Bays Cross Braced	0 bays
Roof Cross Bracing	32mm x 1.2mm Steel Straping	No. of Bays Cross Braced	3 bays

BRACING (continued)			
Side Wall Fly Bracing	120mm x 0.55mm G450 Bracket	No. of Fly Braces per Column	Every Alternate Row (minimum)
Front End Wall Fly Bracing	120mm x 0.55mm G450 Bracket	No. of Fly Braces per Mullion	Every Alternate Row (minimum)
Back End Wall Fly Bracing	120mm x 0.55mm G450 Bracket	No. of Fly Braces per Mullion	Every Alternate Row (minimum)
Roof Fly Bracing	120mm x 0.55mm G450 Bracket	No. of Fly Braces per Rafter	Every Alternate Row (minimum)

SHEETING & FLASHINGS Roof Cladding Type Cu Wall Cladding Type Cu Gutter Type Barge Type Downpipe Type PVC LEFT LEANTO PORTAL FRAME Internal Rafter NA	x 0.55mm G450 Bracket	No. of Fly Braces per Rafter	Every Alternate Row (minimum)
Roof Cladding Type Cu Wall Cladding Type Cu Gutter Type Barge Type Downpipe Type PVC LEFT LEANTO PORTAL FRAME Internal Rafter NA			
Wall Cladding Type Co			
Gutter Type Barge Type Downpipe Type PVC LEFT LEANTO PORTAL FRAME Internal Rafter NA	ustom Orb 0,47 TCT	Roof Cladding Colour	Zincalume
Barge Type Downpipe Type PVC LEFT LEANTO PORTAL FRAME Internal Rafter NA	stom Orb 0.47 TCT	Wall Cladding Colour	Zincalume
Barge Type Downpipe Type PVC LEFT LEANTO PORTAL FRAME Internal Rafter NA	FasciaGutter	Gutter Colour	Zincalume
LEFT LEANTO PORTAL FRAME	Barge	Barge Colour	Zincalume
Internal Rafter NA	90 Round Downpipe	Downpipe Colour	White
Internal Column NA End Rafter NA End Column NA		Internal Rafter Internal Column End Rafter End Column	NA
Eave Purlin NA		Eave Purlin	
BEAMOVER FRAME Beamover Beam (Internal)	NA	Beamover Beam (Outer)	NA
Beamover Rafter	NA	Beamover Rafter Apex Brace	NA
ROLLERDOOR	IVA	Beamover Raiter Apex Brace	NA
Roller Door Width	A 2015	and the second second second second	terior de la companya de la company
Poller Brookley	Upto 3200 mm	Upto 4300 mm	Upto 6000 mm

ROLLERDOOR			
Roller Door Width	Upto 3200 mm	Upto 4300 mm	Upto 6000 mm
Roller Door Header	NA	NA	NA
Side Wall Roller Door Jamb	NA	End Wall Roller Door Jamb	NA

PERSONAL ACCESS DOOR			
Side PA Door Frame	NA	End PA Door Frame	NA

METAL SLIDING DOOR		
Metal Sliding Door Header	NA	